Hardwicke St Senior Housing


17-27 Hardwicke Street, Riverwood Landscape Development Application

DRAWING SCHEDULE

Dwg No.	Drawing Title	Scale
000 001	Coversheet Existing Tree Management Plan	As Shown @ A1 1:150 @ A1
100 101 102 201 202	Landscape Colour Plan General Arrangement Plan 01 General Arrangement Plan 02 Planting Plan 01 Planting Plan 02	1:150 @ A1 1:100 @ A1 1:100 @ A1 1:100 @ A1 1:100 @ A1
500 501	Specification Notes & Plant Schedule Landscape Details	N/A As Shown @ A1



Local Context

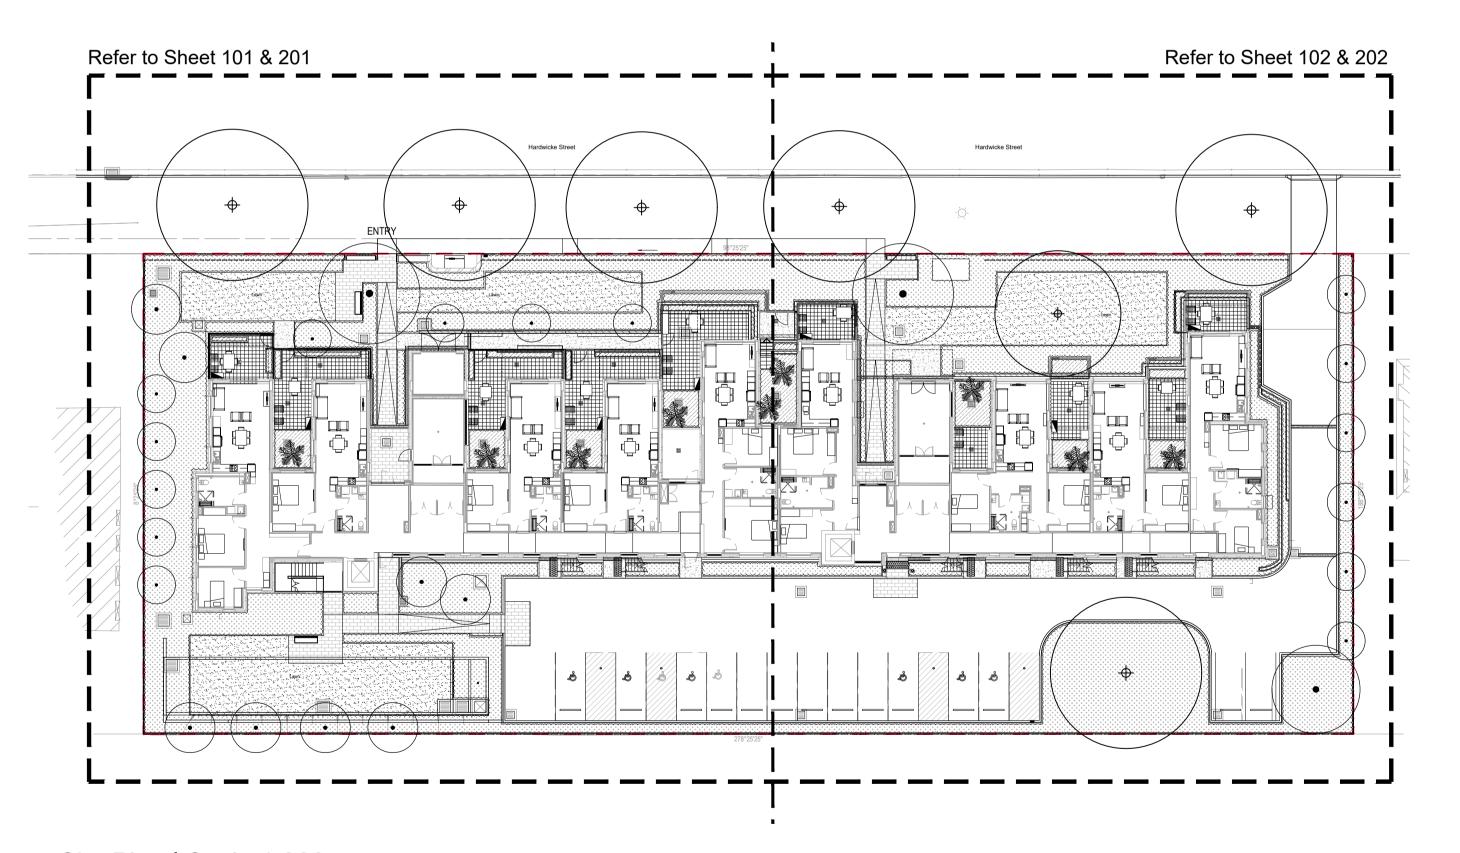

Site Plan | Scale 1:300

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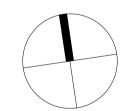
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C Issue for Development Application

B Issue for Development Application A Issue for Information

BS RS 27.06.2024 JW/HT RS 23.01.2024 Drawn Check Date

Issue Revision Description



Land and Housing Corporation (LAHC)

Hardwicke St Senior Housing 17-27 Hardwicke Street, Riverwood

SITE IMAGE

Level 1, 3-5 Baptist Street Redfern NSW 2016

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DEVELOPMENT APPLICATION

Landscape Coversheet

Scale as shown @ A1 SS23-5152

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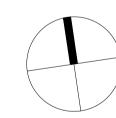
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Existing trees to be retained and protected. Numbers correlate with Arborists Report

Tree protection zone (TPZ). Refer to Arborists

Existing trees to be removed. Numbers correlate with Arborists Report





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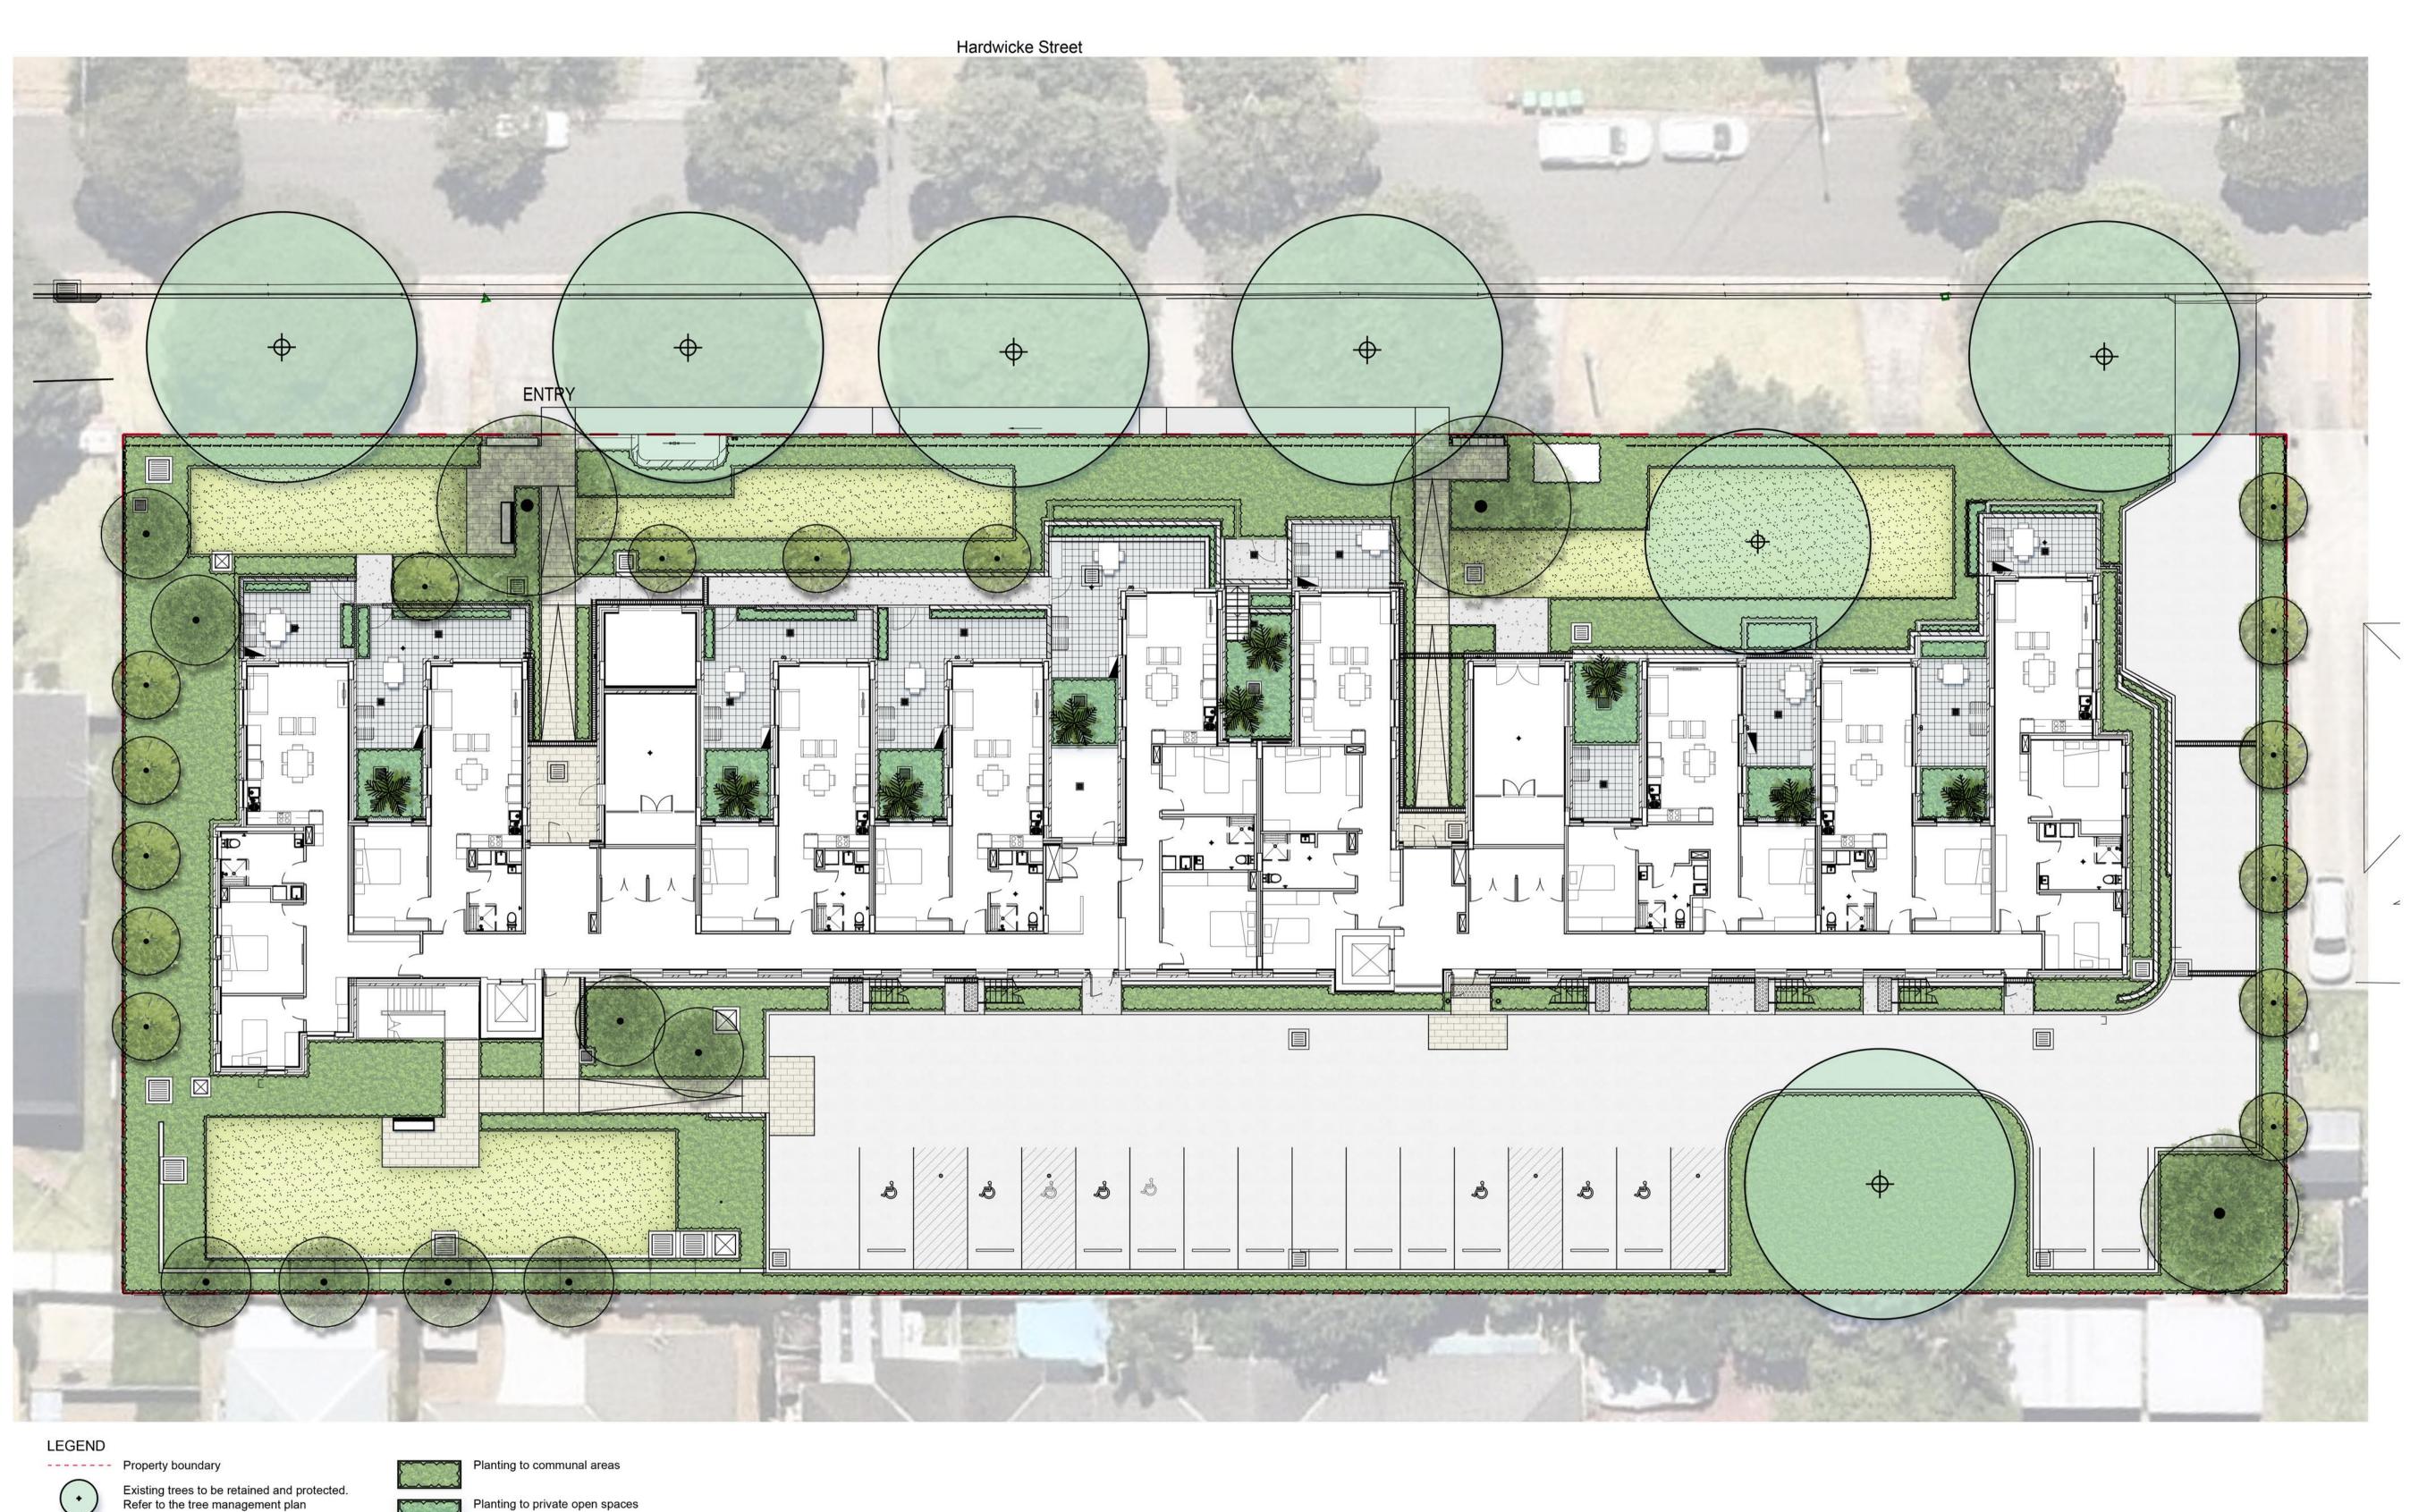
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DEVELOPMENT APPLICATION

Drawing Name
Existing Tree Management Plan

SS23-5152



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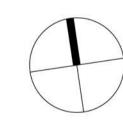
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BS RS 22.08.2024

Legend

Key Plan



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DEVELOPMENT APPLICATION

Drawing Name

Landscape Colour Plan

Washing lines


Retaining walls


Proposed trees and fern planting

Private open space paving


Concrete footpath

Stepping stones

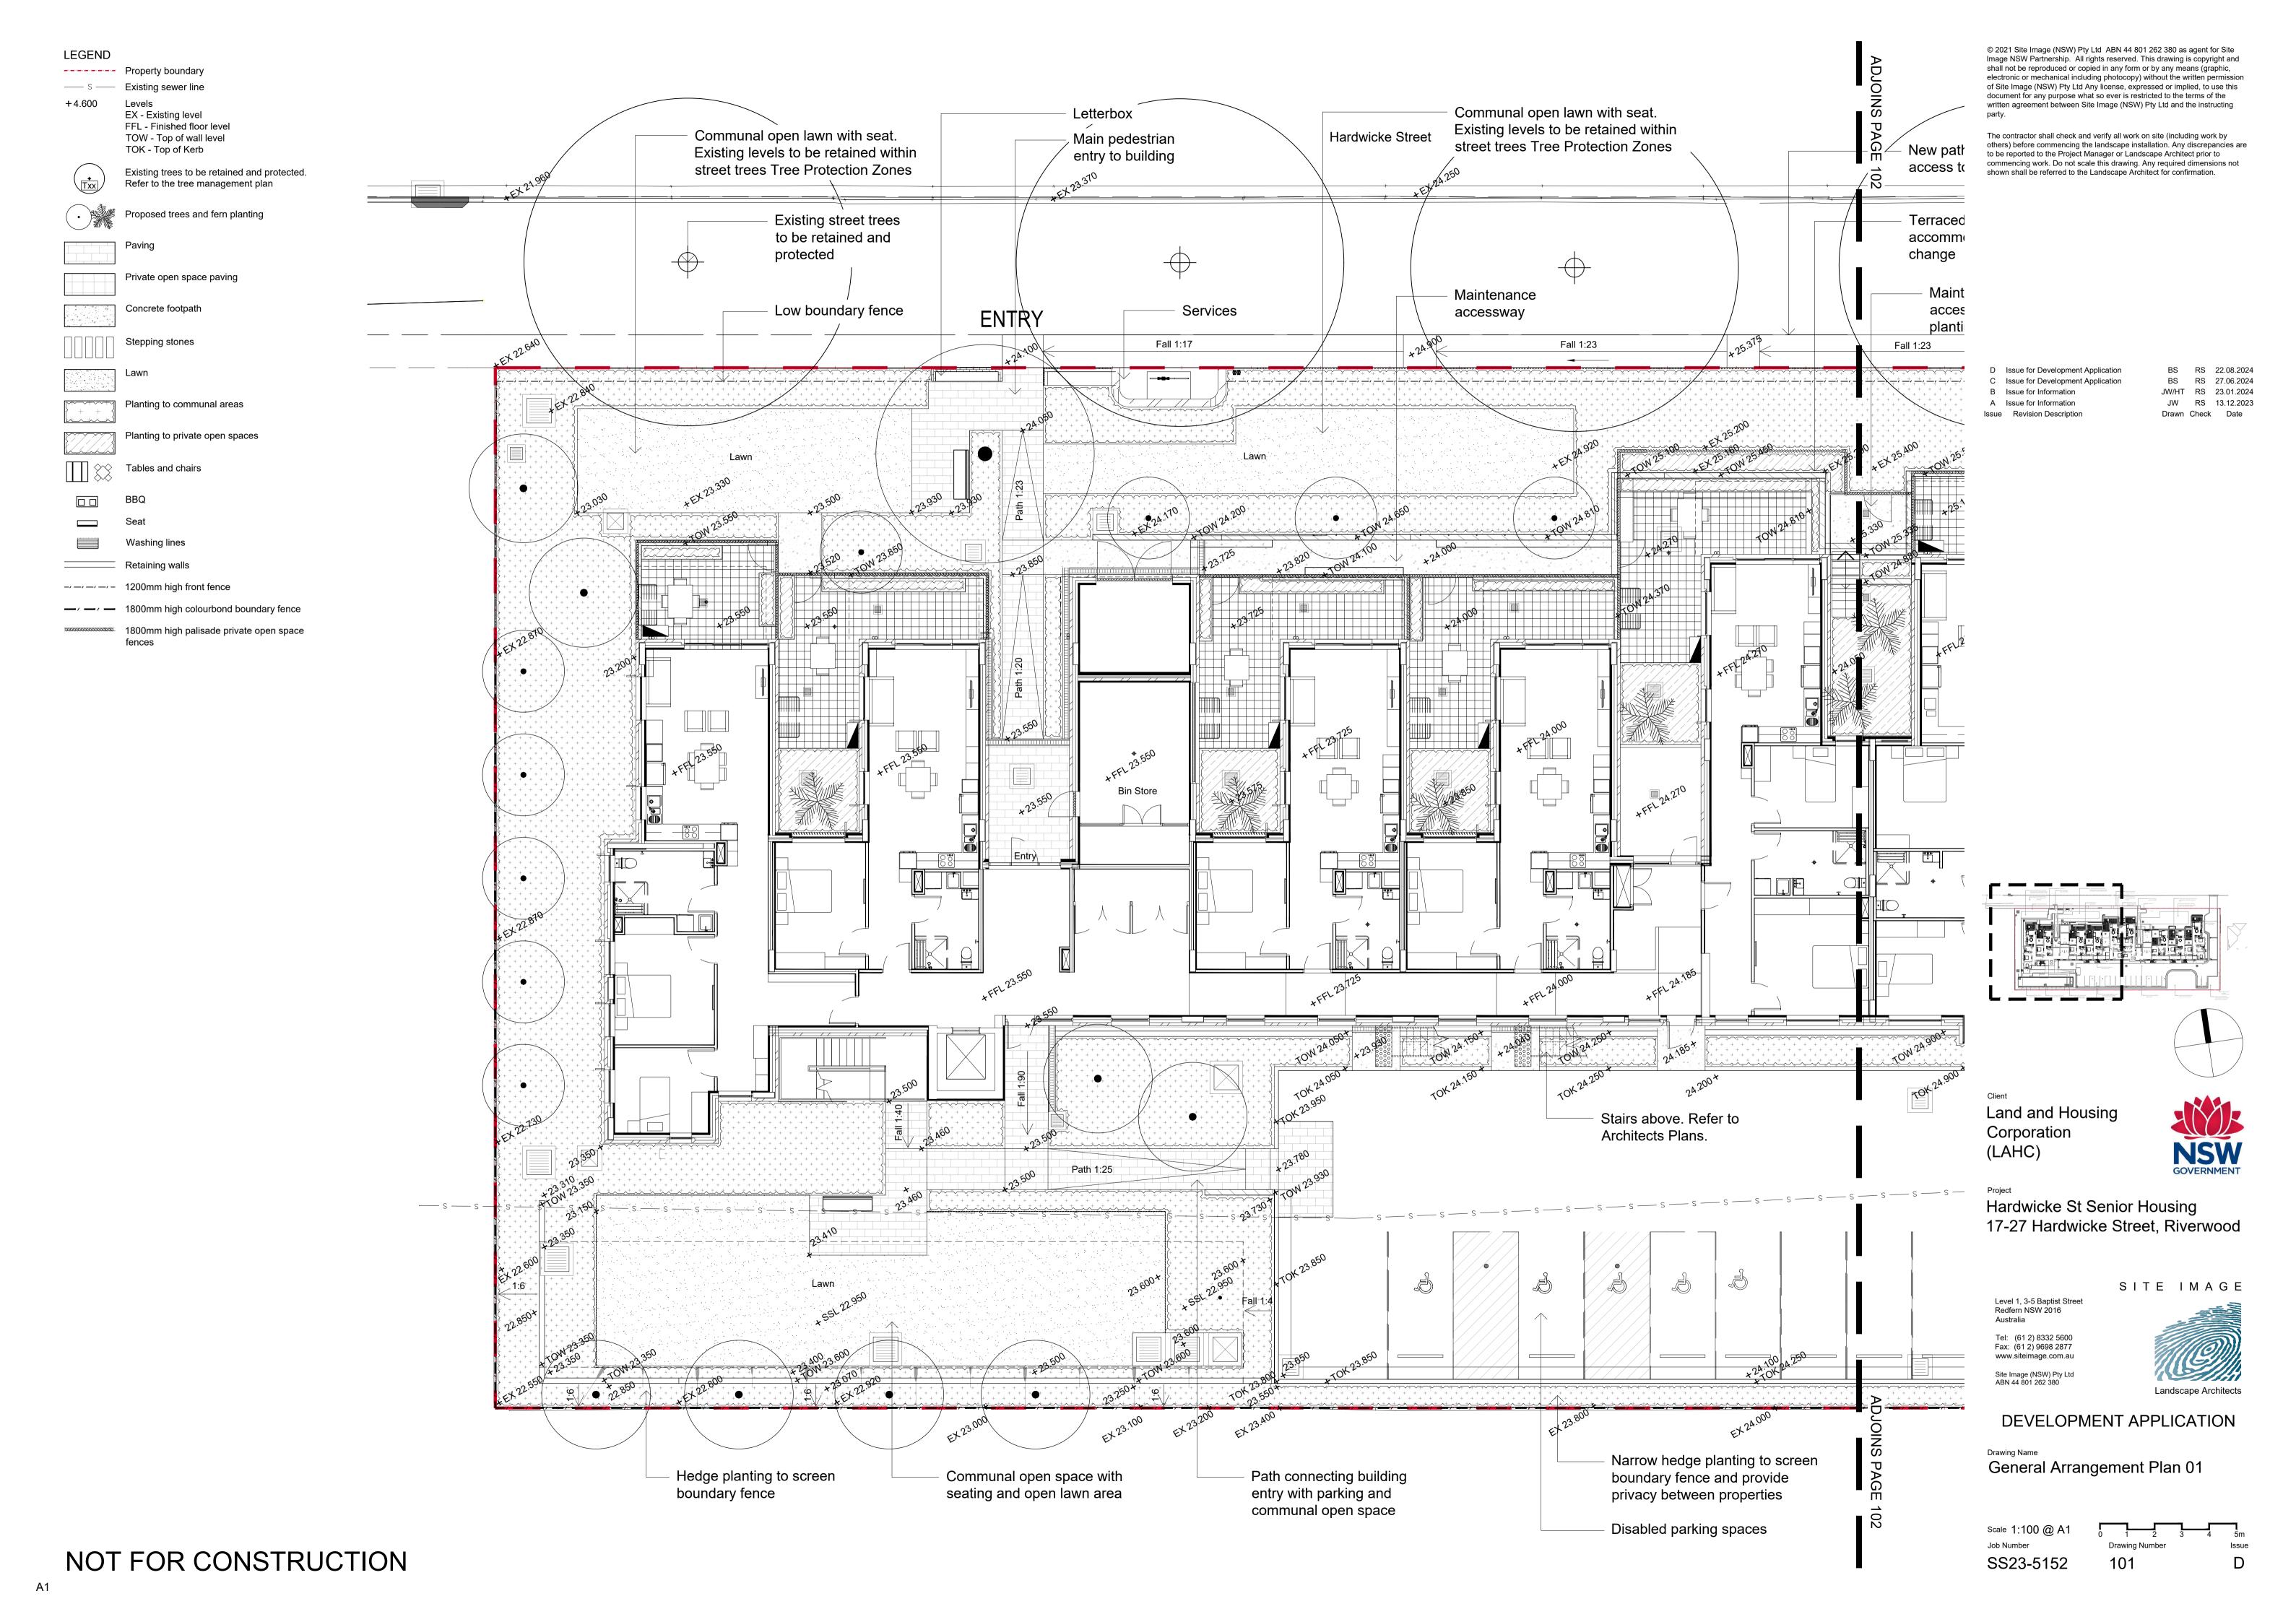

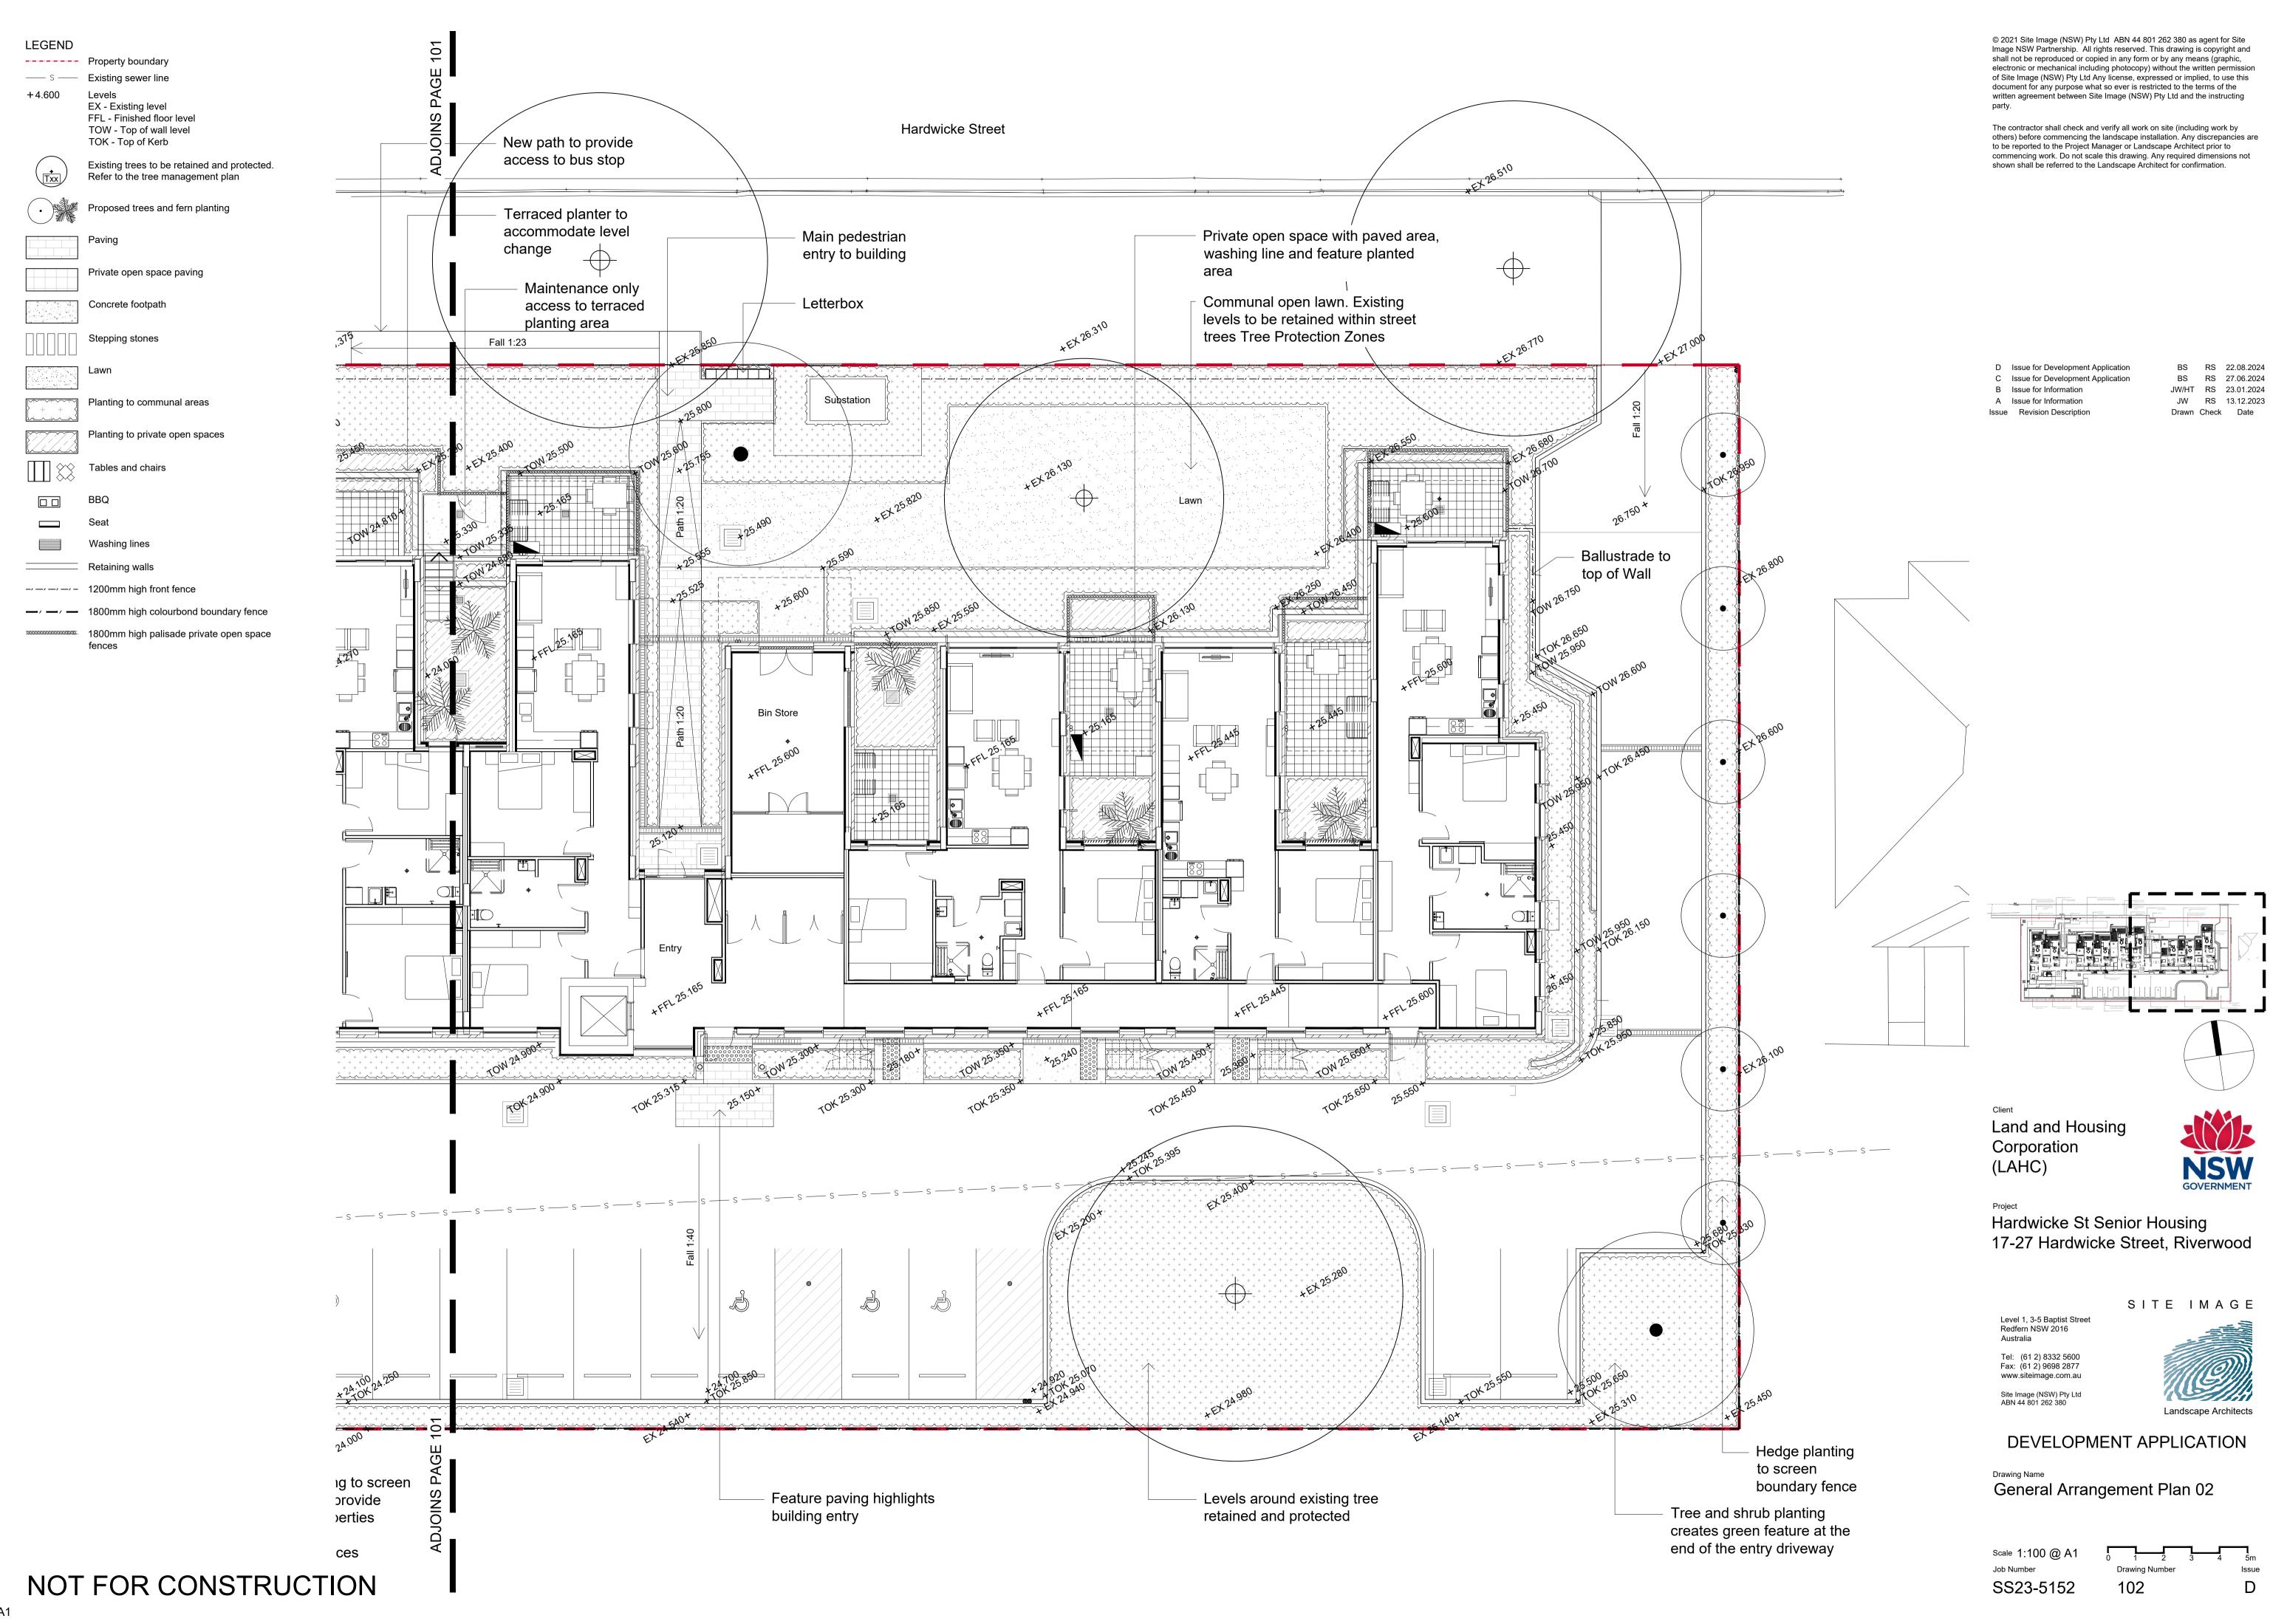

— — — Building overhang / canopy / awning Existing trees to be retained and protected. Refer to the tree management plan

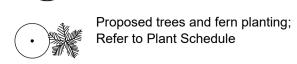

Proposed Shrubs and Accent planting; Refer to Plant Schedule

Proposed Grasses, Groundcover planting; Refer to Plant Schedule

Hardwicke Street

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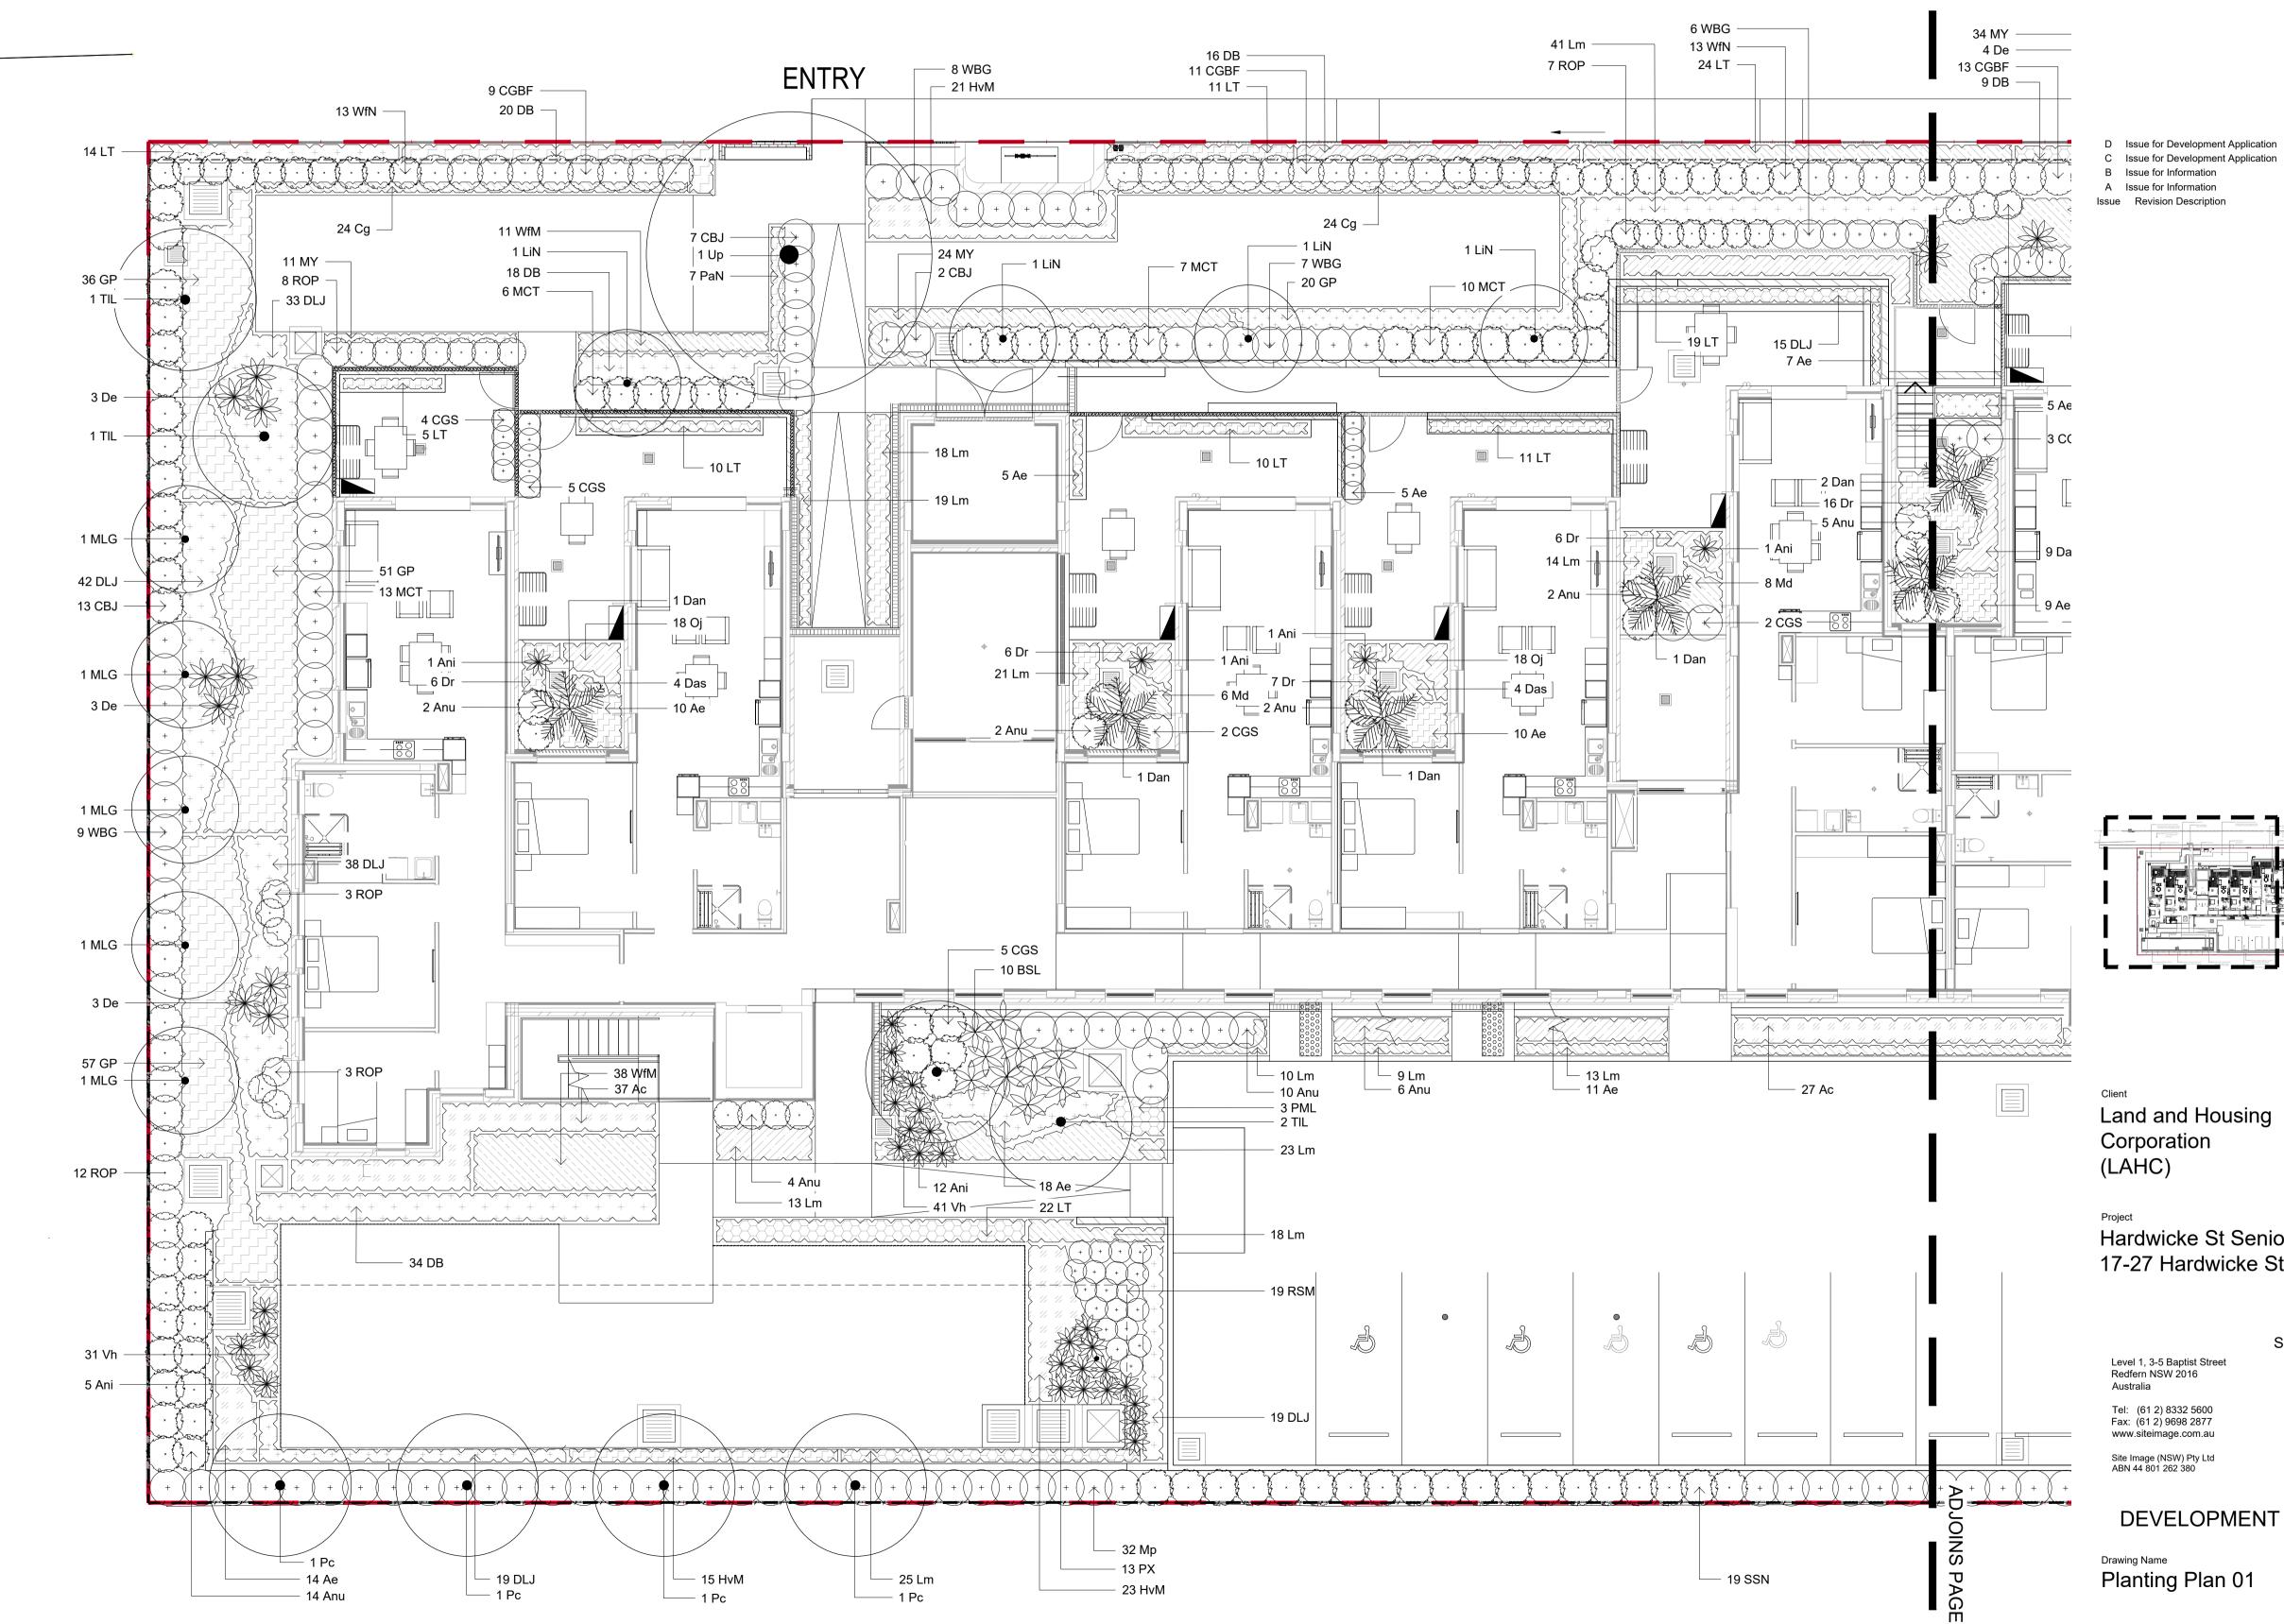
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BS RS 22.08.2024

BS RS 27.06.2024

JW/HT RS 31.01.2024 JW/HT RS 23.01.2024

Drawn Check Date



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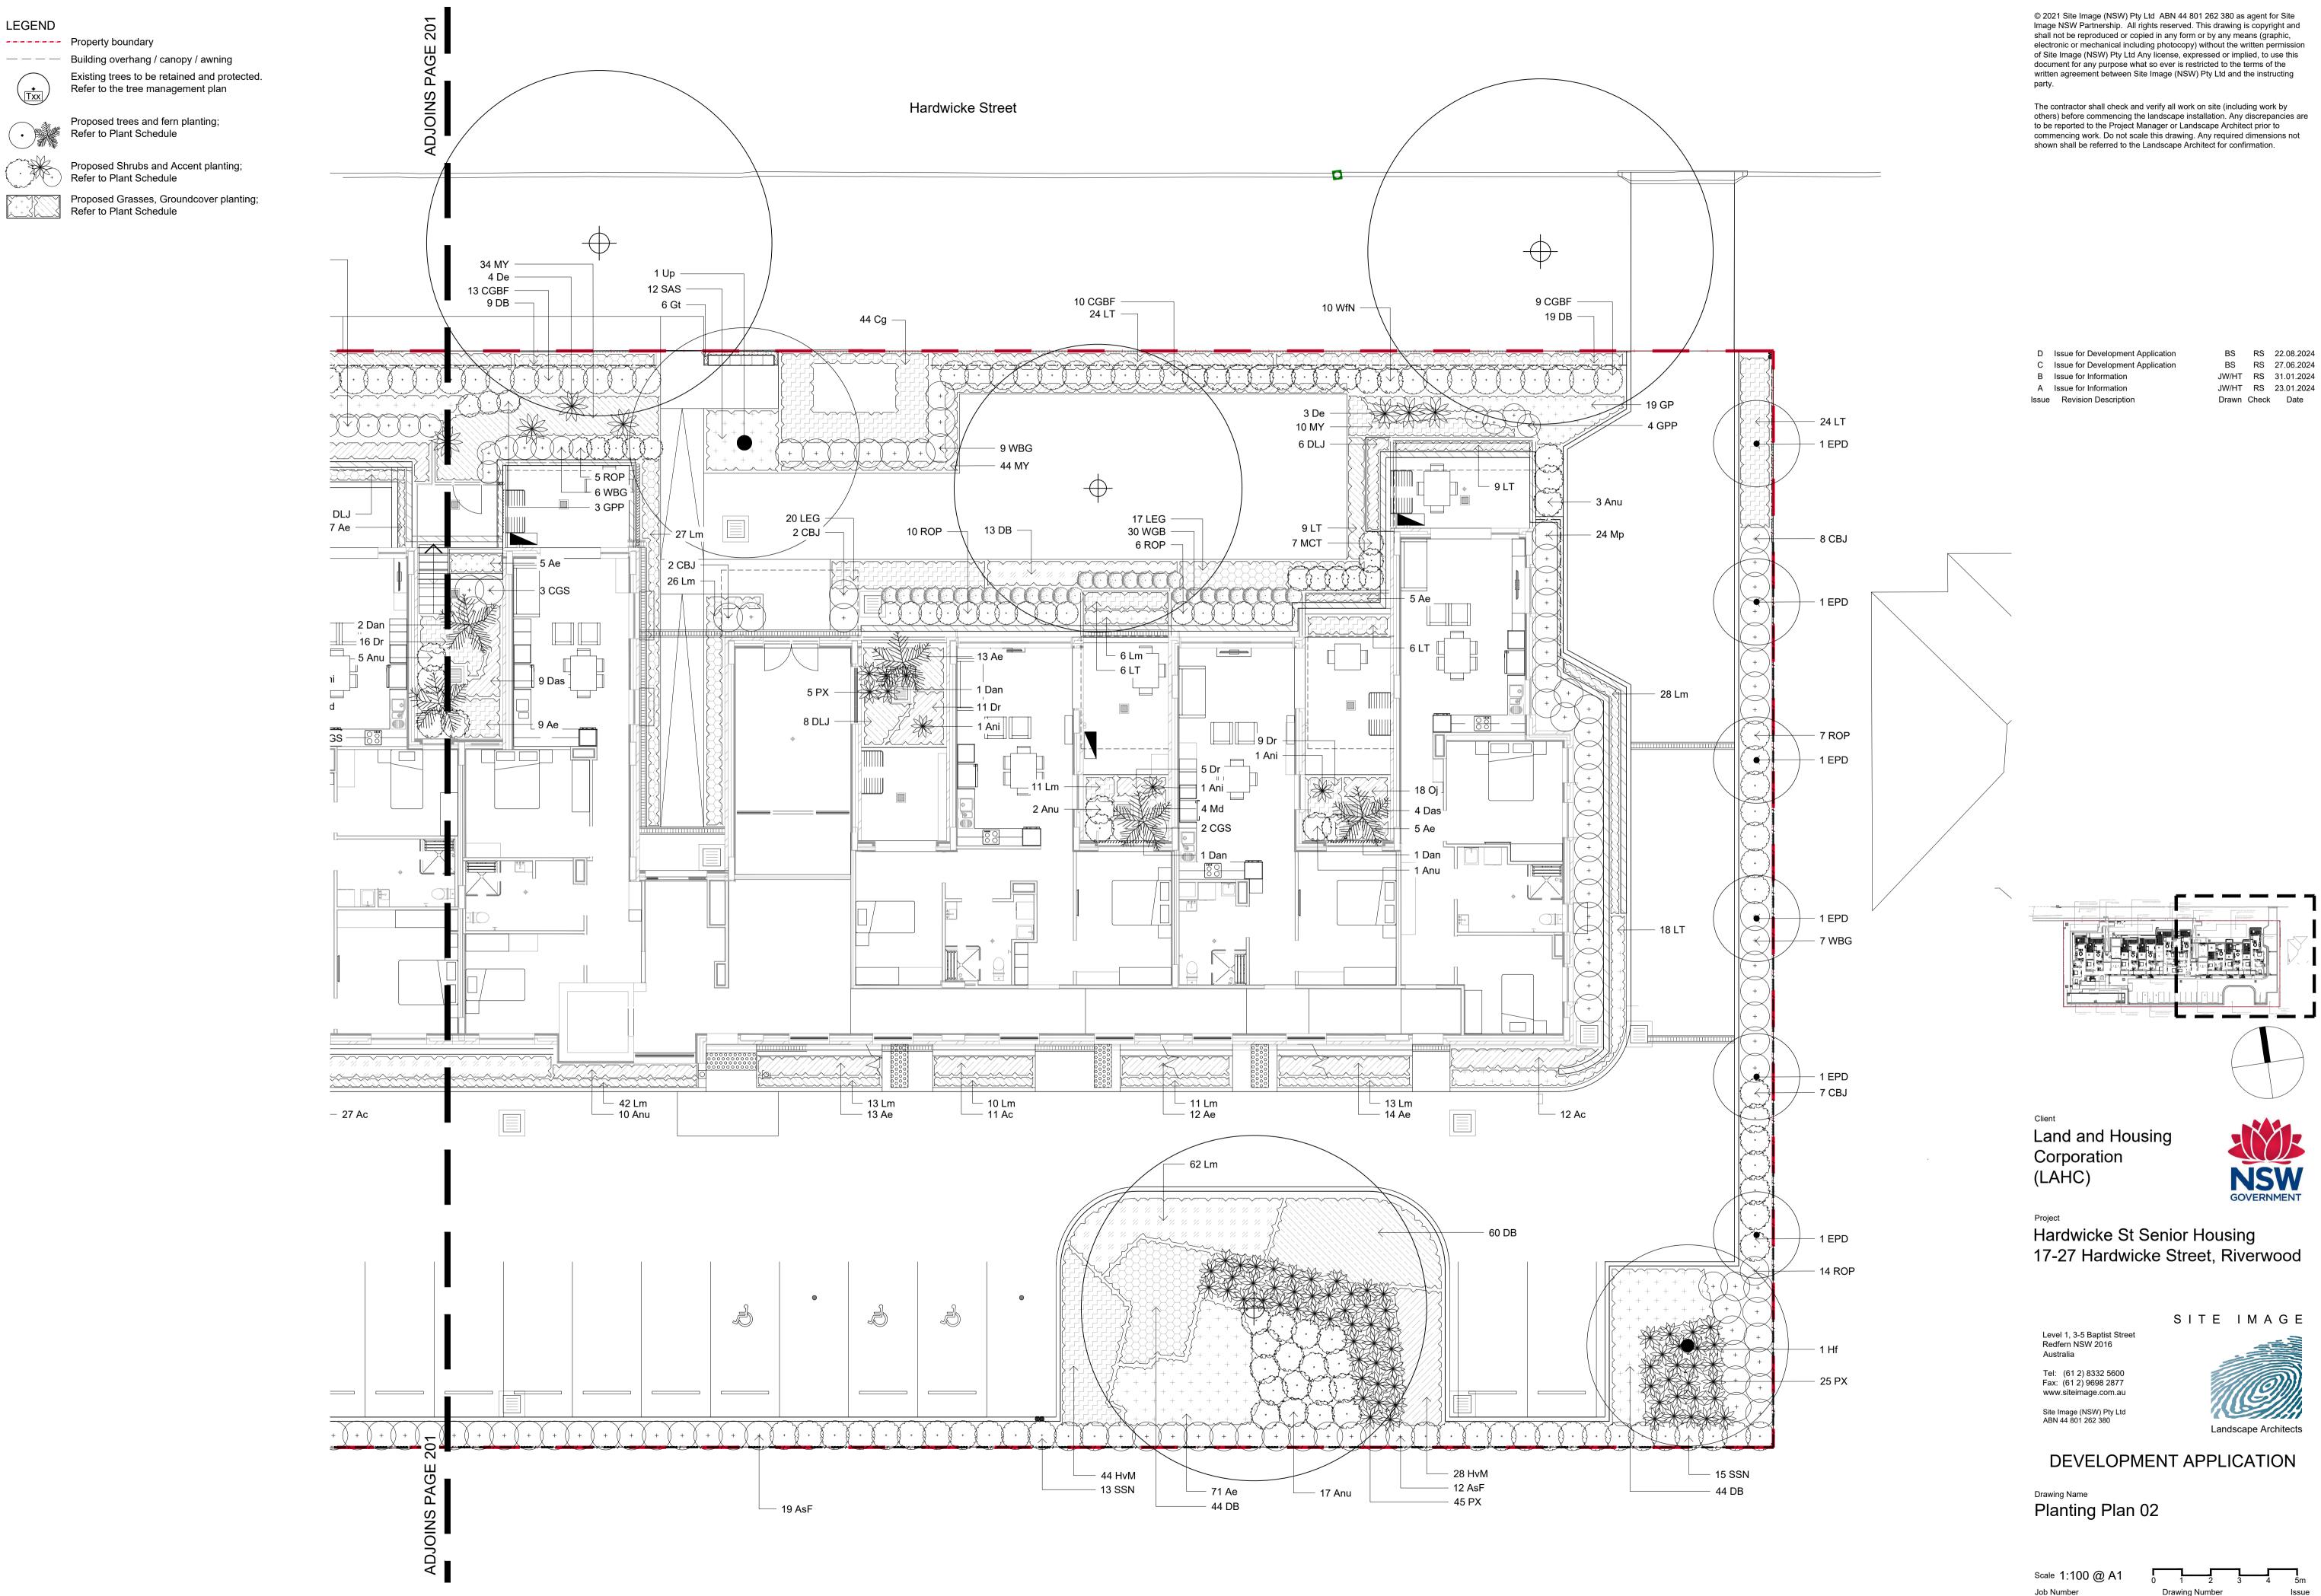


SITE IMAGE

DEVELOPMENT APPLICATION

Drawing Name
Planting Plan 01

Scale 1:100 @ A1 SS23-5152 201



LEGEND

---- Property boundary

Refer to the tree management plan

Proposed trees and fern planting;

Refer to Plant Schedule

Refer to Plant Schedule

Refer to Plant Schedule

SPECIFICATION

GENERAL NOTES

References

All plans and details included in the project documents shall be read in conjunction with this specification. All structural and civil works components of the landscape design shall be referenced to engineers' details and specifications. Read this specification in conjunction with the plant and materials schedules on the drawings. If in doubt about any detail or if conflicts are found in the documents, seek advice.

Workmanship and Materials

The whole of the landscape works shall be carried out by a competent, trained and qualified landscape contractor who is experienced in horticultural practices, landscape construction and planting techniques. The landscape contractor shall hold a current Building Contractors License and/or be a financial member of LNA Landscape Association NSW & ACT or equivalent organisations in other states.

EXISTING TREES AND SHRUBS

Trees and Shrubs to be Retained and Protected

Identify and mark trees and shrubs to be retained using a suitable non-injurious, easily visible and removable means of identification. Protect from damage the trees and shrubs to be retained, including those beyond the site area, both above and below the ground. If a tree becomes damaged during the works or it is proposed to perform work on a tree, give written notice immediately and obtain instructions.

Work Near Trees and Shrubs

Keep the area of the drip-line free from construction material and debris. Do not place bulk materials and harmful materials under foliage canopies or near trees. Do not place spoil from excavations against tree trunks. Prevent wind-blown building materials, such as cement, from covering trees and other plants. Do not remove topsoil from, or add topsoil to, the area within the drip-line of trees.

EARTHWORKS

Excavation, Trimming and Filling

Except as otherwise noted in the contract, bulk excavation is excluded from the landscape works. After the completion of bulk excavation by others, trim and fill the excavated ground surfaces to achieve design levels to accommodate finish materials as detailed. Prepare the sub-grade surface as required for the various finished ground treatments.

Site Drainage

Keep the excavated works drained and free of standing water. Allow to supply and install sub-soil drainage pipes as required for the new works to ensure that all gardens are well drained. Connect the sub-soil drainage pipes to the nearest downstream stormwater pits. Include pipe filter socks and course sharp aggregate backfilling of trenches.

HARDWORKS

Furniture, Handrails, Balustrades

Supply and install the scheduled items in accordance with the manufacturer's recommendations, as detailed and in the locations shown on plan. Provide all footings and fixings required for the items to be stable and in accordance with applicable codes and standards.

Garden Walls, Fences, Steps, TGSI and Edging

Construct garden walls, fences, steps, TGSI and edging as shown on plan, as detailed and of the material scheduled. Provide footings, step nosings, tactile surfaces to comply with Australian Standards and applicable legislation. Refer to engineer's details for structural retaining walls, concrete stairs, concrete strength, reinforcing and joint placement.

Continuous, Unit and Loose Pavement

Install the scheduled material pavement to the locations shown on plan. Ensure that all subgrade/subsurface works are complete prior to commencing paving. Confer with the engineer to ensure the structural integrity of the subgrade. Ensure that the base course under paved surfaces is a continuous plane offering a constant depth of bedding material not exceeding 50mm. If laying unit pavers in a cement mortar bed on a concrete sub-base ensure that joints in paving match the location of joints in the concrete. Refer to engineer's details for heavy duty slabs, concrete stairs, concrete strength, reinforcing, and joint type and placement.

Landscape Structures

All landscape structures shall have a common appearance in detail and material content while providing for the functional design requirements. The structure of all elements shall consist of a base frame of structural grade hardwood timber of sizes that sustain spans and maintain stability. Refer to drawn details for further information.

SOFTWORKS

Site Soil Testing

Where site soil is to be retrieved from site and stored on site for reuse, undertake at least two (2) soil tests in locations as advised by the Project Manager or as shown on the plans. Provide results and recommendations regarding soil additives for the benefit of healthy plant growth and to adjust the soil components to achieve an appropriate planting medium for successful plant development. Where topsoil is imported to site no testing of the imported soil is necessary but ensure that imported soil can b e supplied with test data to verify that it suits the design plants.

Excavate and/or fill all garden beds to bring the top of subsoil to at least 300mm below finished design soil levels. Excavate all turf areas to bring the subsoil to at least 100mm below finished design levels. In all areas shape the subsoil to fall to subsoil drains where applicable. Do not excavate within the drip line of trees and shrubs to be retained. Cultivate or rip the subsoil to a further depth of 100mm before placing top soil. Remove stones of size exceeding 25mm, clods of earth exceeding 50mm, and weeds, rubbish or other deleterious material brought to the surface during cultivation. Do not disturb services or existing tree roots. If necessary, cultivate these areas by hand. During cultivation, thoroughly mix in materials required to be incorporated into the subsoil, as recommended in the soil testing results and to manufacturer's recommendations. Trim the surface to design levels again after cultivation.

NOT FOR CONSTRUCTION

Subsoil Drainage

Provide and install subsoil drainage equal to Vinidex 65mm (min) Draincoil with filter sock at the base of slopes, on the high side of paths, at the base behind retaining walls and where water is likely to accumulate at depth in the soil. Connect all subsoil drainage to the nearest downstream stormwater pit to ensure that subsoil water is managed and channelled to a stormwater drainage system. On sites with cross fall of less than 1:50 install subsoil drains to remove excess water from the subsoil in areas where water is likely to accumulate and may not penetrate lower strata naturally. Rip the sub-base surface 150mm deep before placing any soil. Install drainage pipes in subsoil trenches backfilled with 10mm blue metal (basalt) equal to ANL Blue Metal.

Coordinate the connection of subsoil drains to stormwater pits with the Civil or Hydraulic contractor.

Topsoil

Import topsoil for the garden and turf areas, unless the topsoil can be provided from material recovered from the site, as recommended in the soil testing results. Spread the topsoil on the prepared subsoil and grade evenly, compact lightly and uniformly in 150mm layers. Avoid differential subsidence and excess compaction and produce a finished topsoil surface which has the following characteristics:

- Finished to design levels, allowing for mulch or turf, which is to finish flush
- with adjoining hard surfaces such as paths and edges; • Smooth and free from inorganic matter, stones or clods of soil;
- Graded to drain freely, without ponding, to catchment and/or sub-soil
- Graded evenly to adjoining surfaces; and
- Ready for planting.

Provide, in accordance with AS 4454, well rotted vegetative material or animal manure, free from harmful chemicals, inorganic matter, grass, weeds and the reproductive parts of unwanted plants.

Provide proprietary fertilisers, delivered to the site in sealed containers marked to show manufacturer or vendor, weight, fertiliser type, N:P:K ratio. recommended uses, application rates and safety procedures. Apply appropriate fertiliser suited to the provenance of plants (indigenous or exotic) included in the design.

Supply plants in accordance with the landscape design drawings and schedules, which have the following characteristics:

- Large healthy root systems, with no evidence of root curl, restriction or
- Vigorous, well established, free from disease and pests, of good form
- consistent with the species/variety; • Hardened off, not soft or forced, and suitable for planting in the natural climatic conditions prevailing at the site in full sun, partial shade or full
- Grown in final containers for not less than twelve weeks;
- Trees, unless required to be multi-stemmed, shall have a single leading shoot: and
- Containers shall be free from weeds and of appropriate size in relation to the specified plant size.

Following excavation of the planting hole, place and spread 15gms of wetting agent pre-mixed with one (1) litre of water. Place the plant correctly orientated to north or for best presentation. Backfill the planting holes with specified topsoil mixture. Lightly tamp and water to eliminate air pockets Ensure that the backfill soil is not placed over the top of the root ball and that the root ball is not higher than the soil in which it is planted. Apply fertiliser, as specified around the plants in the soil at the time of planting.

Root Barrier

Supply and install root control barriers to all new tree plantings adjacent to walls, paths, kerbs and all service trenches, where their proximity poses a threat to the stability of the built infrastructure. Install in accordance with manufacturer's recommendations.

Unless noted otherwise, mulch shall be approved proprietary recycled wood fibre or pine bark material. Place mulch in all garden beds to a depth of 75mm after all specified plants are installed. Keep mulch clear of all plant stems and rake to an even plane, flush with the surrounding surfaces evenly graded between design surface levels. Over fill to allow mulch to settle to the specified depth.

Stakes and Ties

Stakes shall be durable hardwood, straight, free of knots and twists, pointed at one end, in the following quantities and sizes for each of the various plant

- Plants >25 lt: 1 off 38 x 38 x 1200mm;
- Semi-advanced plants >75 lt: 2 off 50x50x 1800mm;
- Advanced plants >100 lt: 3 off 50 x 50 x 2400mm.

Turf

Turf shall be delivered to site as 25mm minimum thick cut rolls. Obtain turf from a specialist grower of cultivated turf. Turf shall have an even thickness, free from weeds and other foreign matter. Deliver turf to the site within 24 hours of being cut and lay it within 24 hours of delivery. Prevent it form drying out between cutting and laying. Lay the turf in the following manner:

- In stretcher pattern, joints staggered and close butted;
- Parallel long sides of level areas, with contours on slopes; and
- To finish flush, after lightly tamping, with adjacent finished surfaces and design levels.

Species: Stenotaphrum secundatum Sir Walter Soft-leaf Buffalo.

LANDSCAPE MAINTENANCE

The Landscape Contractor shall rectify defects during installation and that become apparent in the works under normal use for the duration of the contract Defects Liability Period. Unless contracted otherwise, the Landscape Contractor shall maintain the contract areas by the implementation of industry accepted horticultural practices for 52 weeks from Practical Completion of the works. The landscape maintenance works shall include, but not be limited to:

- Replacing failed plants;
- Pruning;
- Insect and pest control; Fertilising;
- Maintaining and removing stakes and ties;
- Maintaining mulch;

Mowing and top dressing;

Weeding and rubbish removal.

- Irrigation and watering:
- Erosion control; and

Maintenance Log Book Implement and keep a maintenance log book recording when and what maintenance work has been undertaken and what materials, actions and decisions have been used, implemented and concluded to keep the landscape always looking its best. Enter data daily and review information every 2 weeks. Observe trends and develop a maintenance regime around seasonal and observed event occurrences.

Maintenance Activities

During the defect maintenance period schedule the following activities to occur on a timely basis.

Plant replacement - Replace plants that have failed to mature, die or are damaged. Replacement plants shall be in a similar size and quality and identical species or variety to the plant that has failed. Replacement of plants shall be at the cost of the landscape contractor unless advised otherwise. If the cause of the failure is due to a controllable situation then correct the situation prior to replacing plants. Observe and replace failed plants within 2 weeks of observation.

Pruning - Prune dead wood, broken limbs, dead or infected foliage and as needed to develop strong, healthy plants to achieve the shape and form expected of the plant type. Observe daily and prune plants as necessary to maintain acceptable growth habit.

Insect, disease and pest control - Avoid spraying:

- if ever possible;
- in wet weather or if wet weather is imminent;
- if target plants are still wet after rain;
- in windy weather; and if non-target species are too close.

Immediately report to the Project Manager any evidence of intensive weed infestation, insect attack or disease amongst plant material. Submit all proposals to apply chemicals and obtain approval before starting this work. When approved, spray with herbicide, insecticide, fungicide as appropriate in accordance with the manufacturers' recommendations. Observe daily and act as necessary to control any infestation or disease. Record in the logbook all relevant details of spraying activities including:

- Product brand / manufacturer's name,
- Chemical / product name,
- Chemical contents.
- Application quantity and rate,
- Date of application and location.
- Results of application, and Use approval authority.

Fertilise gardens with a proprietary slow release fertiliser applied in accordance with the manufacturer's directions and recommendations. Apply

- 6-12 monthly. Record in the logbook all relevant details of fertilising including:
- Product brand / manufacturer's name, Fertiliser / product name,
- Application quantity and rate, and

Date of application and location.

Stakes and ties - Adjust and replace as required to ensure plants remain correctly staked. Remove those not required at the end of the planting establishment period (Defects Liability Period). Inspect and act at least every

Maintaining mulch - Maintain the surface in a clean, tidy and weed free condition and reinstate the mulch as necessary to ensure correct depth as specified. Observe weekly and replenish mulch as required.

Mowing and top dressing - Mow the turf to maintain a grass height of between 30-50mm. Do not remove more than one third of the grass height at any one time. Remove grass clippings from the site after each mowing. Top dress to a maximum of 10mm to fill depressions and hollows in the surface. Mow weekly/fortnightly in warmer months. Mow monthly or as required in cooler months. Top dress at approximately 6 monthly intervals.

Irrigation and watering - Maintain the irrigation system to sure that each individual plant receives the required amount of water to maintain healthy and vigorous growth. Adjust and calibrate as required. Provide additional watering, if necessary but inspect irrigation weekly and make repairs as necessary.

Weeding and rubbish removal - During the plant establishment period remove by hand, rubbish and weed growth that may occur or re-occur throughout all planted, mulched and paved areas. The contractor shall target weeds that are capable of producing a major infestation of unwanted plants by seed distribution. Whenever possible, time weed removal to precede flowering and seed set. Constant observation and removal of weeds is

Symbol	Botanic Name	Common Name	Mature	QTY
			H x W (m)	
REES				
Dan	Dick sonia antarctica	Soft Tree Fern	2.0 x 2.0	9
EPD	Elaeocarpus reticulatus 'Prima Donna'	Blueberry Ash	7.0 x 3.0	6
Hf	Hymenosporum flavum	Native Frangipani	15.0 x 7.0	1
LiN	Lagerstroemia indica 'Natchez'	Crepe Myrtle	6.0 x 3.0	4
MLG	Magnolia grandiflora 'Little Gem'	Magnolia Little Gem	6.0 x 3.0	5
Pc	Pistachia chinensis	Chinese Pistachio	8.0 x 4.0	4
TIL	Tristaniopsis laurina 'Luscious'	Water Gum	8.0 x 4.0	4
Up	Ulmus parvifolia	Chinese Elm	10.0 x 8.0	2
CCENTS / SH	JDI IDE			
	Acmena smithii 'Firescreen'	Firegeroen Lilly Dilly	10 × 10	21
AsF		Firescreen Lilly Pilly	4.0 x 4.0	31
Ae	Aspidistra elatior	Cast Iron Plant	0.6 x 1.2	227
Ani	Asplenium nidus	Birds Nest Fern	0.8 x 0.8	24
Anu	Alpinia nutans	Dwarf Cardamom	1.0 x 1.0	80
BSL	Blechnum 'Silver Lady'	Gristle Fern	1.5 x 1.5	10
CBJ	Callistemon 'Better John'	Bottlebrush	1.0 x 1.0	41
CGBF	Callistemon 'Great Balls of Fire'	Bottlebrush	1.5 x 1.5	52
CGS	Ctenanthe setosa 'Grey Star'	Grey Star Ctenanthe	1.0 x 1.0	23
De	Doryanthes exselsa	Gymea Lily	2.0 x 2.0	16
GPP	Grevillea 'Pink Pearl'	Pink Pearl Grevillea	1.0 x 1.0	7
MCT	Melaleuca 'Claret Tops'	Dwarf Honey Myrtle	0.8 x 1.0	43
Mp	Murraya paniculata	Orange Jasmine	3.0 x 2.0	56
PX	Philodendron 'Xanadu'	Dwarf Philodendron	0.6 x 0.6	88
ROP	Rhaphiologis indica 'Oriental Pearl'	Indian Hawthorn	1.0 x 1.0	75
RSM	Rhaphiolepis indica 'Snow Maiden'	Indian Hawthorn	0.8 x 0.8	19
SSN	Syzygium australe 'Straight and Narrow'	Straight & Narrow Lilly Pilly	5.0 x 1.5	47
WBG	Westringia fruticosa 'Blue Gem'	Coastal Rosemary	0.8 x 0.8	52
WfN	Westringia fruticosa 'Naringa'	Coastal Rosemary	1.0 x 1.6	36
WGB	Westringia fruticosa 'Grey Box'	Coastal Rosemary	0.5 x 0.5	30
RASSES / G	_			
Ac	Arthopodium cirratum	Renga Lily	0.6 x 0.6	87
Cg	Carpobrotus glaucescens	Pig Face	0.2 x 1.0	92
 Das	Doodia aspera	Rasp Fern	0.3 x 0.4	21
DB	Dianella 'Breeze'	Breeze Flax Lily	0.7 x 0.6	277
DLJ	Dianella 'Little Jess'	Flax Lily	0.4 × 0.4	180
Dr	Dichondra repens	Kidney Weed	0.1 x 1.0	66
GP	Grevillea 'Poorinda Royal Mantle'	Grevillea	0.1 x 3.0	183
Gt	Gazania tormentosa	Silver Gazania	0.2 x 0.5	6
H∨M	Hardenbergia violacea 'Meema'	Hardenbergia Meema	0.4 x 2.0	131
LEG	Liriope 'Evergreen Giant'	Giant Liriope	0.6 x 0.6	37
Lm	Liriope muscari	Liriope	0.4 × 0.4	473
LT	Lomandra 'Tanika'	Lomandra Tanika	0.5 x 0.5	222
Md	Microsorum diversifolium	Kangaroo Fern	0.3 x 0.6	18
MY	Myoporum parvifolium 'Yareena'	Creeping boobialla	0.1 x 1.0	123
Oj	Ophiopogon japonicus	Dwarf Lilyturf	0.2 x 0.3	54
PaN	Pennisetum alopercuroides 'Nafray'	Nafray Pennisetum	0.6 x 0.6	7
PML	Plectranthus hybrida 'Mona Lavender'	Mona Lavender	0.7×0.7	3
SAS	Scaevola aemula 'Aussie Salute'	Fan Flower	0.5 x 2.0	12
Vh	Viola hederacea	Native Violet	0.1 x 0.3	72
WfM	Westringia fruticosa 'Mundi'	Coastal Rosemary	0.5 x 1.5	49
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Land and Housing Corporation

(LAHC)

Hardwicke St Senior Housing 17-27 Hardwicke Street, Riverwood

SITE IMAGE

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Site Image (NSW) Pty Ltd

ABN 44 801 262 380

Level 1, 3-5 Baptist Street

Landscape Architects

DEVELOPMENT APPLICATION

Specification Notes & Plant Schedule


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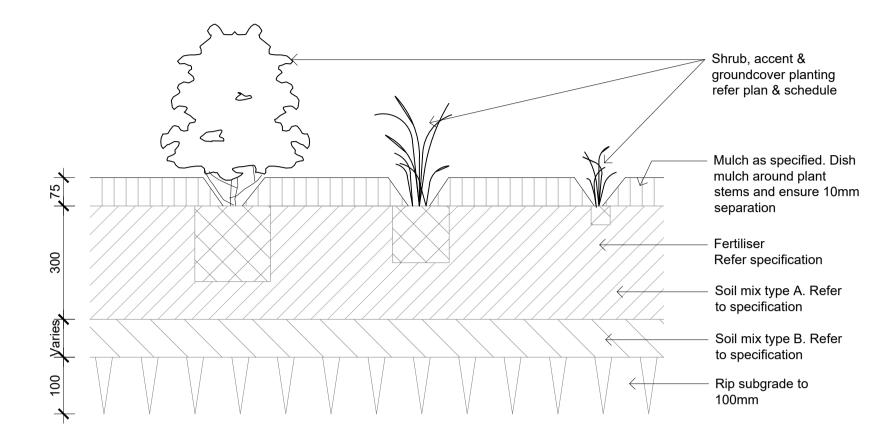
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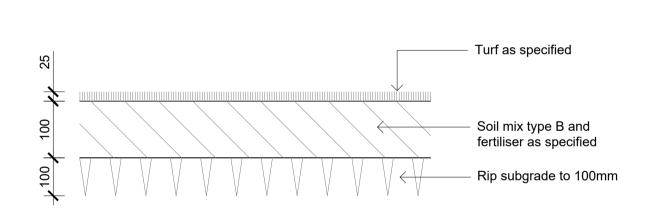
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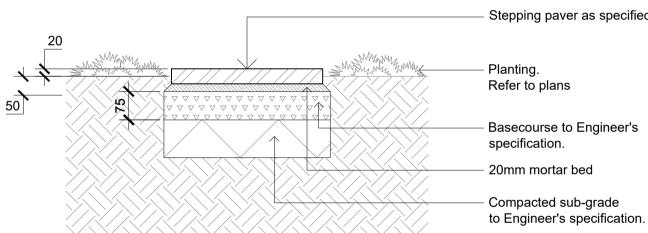
01 Tree Planting on Grade




O2 Shrub, Accent & Groundcover Planting on Grade 501 1:10




04 Turf on Grade 501 1:10

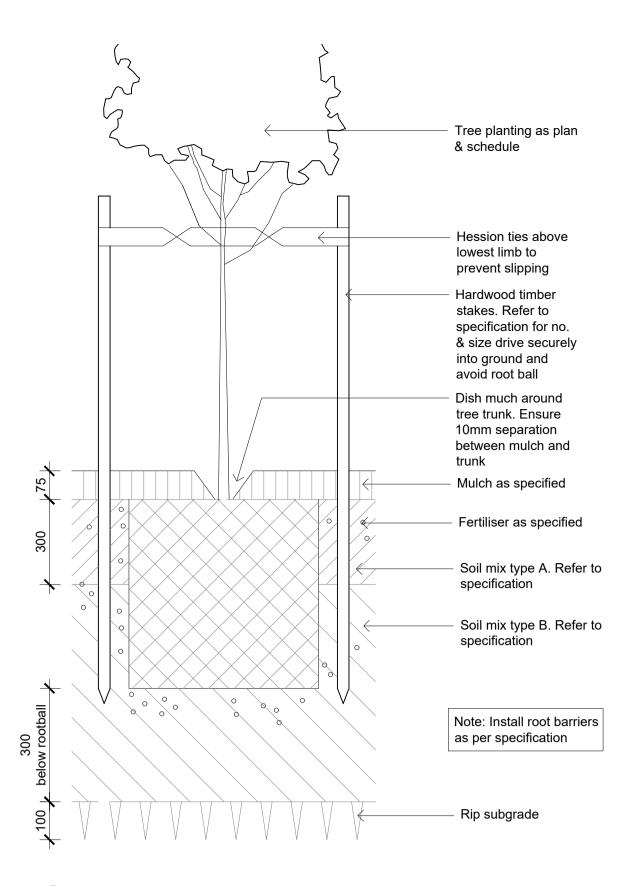

501 1:10

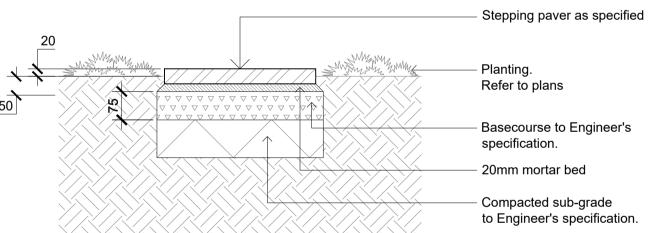

05 Stepping Paver

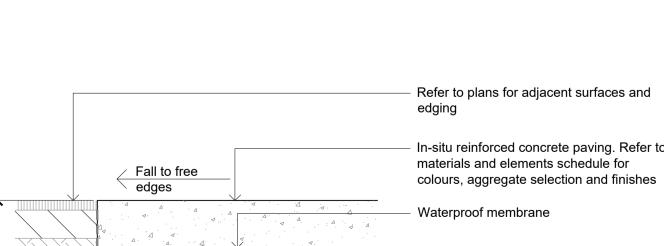

07 Concrete Paving 501 1:10

In-situ reinforced concrete paving. Refer to Compacted sub-base to engineers specification Compacted sub-grade to an even surface that allows the finished paving to meet design

Shrub, accent & groundcover planting - Mulch Existing soil Planting hole 2 x depth and width of rootball Soil type A

03 Pocket Planting in existing trees TPZ

Property boundary Adjacent surface on neighbouring property or road verge Galvanised mild steel edge 6 x 125mm edging to finish flush with adjacent surfaces Planting area refer to detail - Planting soil to be set 20mm below top of kerb and mulch raked down at edges Weld anchor rod to edge and paint with rust resistant paint. Set rod 40mm below top of steel edge Nom. 10mm dia x 300mm galvanised mild steel rod welded to steel edge at min 1m centres, ends and as required. Ensure anchors are driven down into firm

subgrade.

06 Steel Edge

501 1:10

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The contractor shall check and verify all work on site (including work by others) before commencing the landscape installation. Any discrepancies are to be reported to the Project Manager or Landscape Architect prior to commencing work. Do not scale this drawing. Any required dimensions not shown shall be referred to the Landscape Architect for confirmation.

B Issue for Development Application A Issue for Approval

Issue Revision Description

BS RS 27.06.2024 JW/HT RS 23.01.2024 Drawn Check Date

Land and Housing Corporation (LAHC)



Hardwicke St Senior Housing 17-27 Hardwicke Street, Riverwood

Level 1, 3-5 Baptist Street Redfern NSW 2016

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DEVELOPMENT APPLICATION

Drawing Name

Landscape Details

Scale as shown @ A1

SS23-5152

501